



June 15, 2020

ECS Project No. ECS-2020-0003

Manitoba Conservation and Climate  
1007 Century Street  
Winnipeg, Manitoba  
R3H 0W4

Attention: Ms. Shannon Kohler  
Acting Director, Environmental Compliance & Enforcement Branch

**Re: Construction of New Landfill Cell  
Licence No. 3181  
Municipal Waste Management Ltd. SW 35-8-21 W Landfill  
Municipality of Souris-Glenwood, Manitoba**

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Dear Ms. Kohler,

Environmental Consulting Solutions (ECS) was retained by Municipal Waste Management Environmental (MWM) to design and engineer a new landfill cell at their Class I Waste Disposal Ground (Licence No. 3181) located at SW ¼ 35-8-21 WPM in the Municipality of Souris -Glenwood in accordance with MWM's proposal filed under *The Environmental Act* on January 5, 2016.

As outlined in MWM's Licence (No. 3181) final engineered design plans have been prepared and attached. Engineered design plans for the new cell construction have addressed the following at a minimum as per MWM's Class I Licence:

- Engineering design with respect to construction of the waste disposal cell base and sides or cut-off walls;
- Engineering design with respect to the construction of the leachate collection system in each new cell, and connections, if applicable, to the overall leachate management system;
- Location of access road(s) to the waste disposal cell;
- Details of the location of the waste disposal cell with respect to property lines; and
- Details of a drainage system to prevent water from entering the waste disposal cell and to channel the surface run-off into the surface water system for the Development.


We trust that the enclosed is sufficient for Manitoba Conservation and Climate, if you have any questions or require additional information please contact us at (204) 901-1530.

Yours very truly,

## ENVIRONMENTAL CONSULTING SOLUTIONS



Doug Dolby, Dipl. T. Env.  
Environmental Specialist

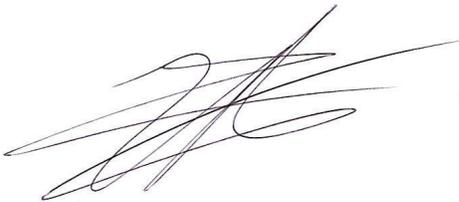

Curtis Navrati, P. Eng.  
Senior Engineer  
LW Diamond Environmental Services



Attachment: Final Engineering Design Plans – Municipal Waste Management Ltd.  
SW 35-8-21 W Landfill (Licence No. 3181), Municipality of Souris-  
Glenwood, Manitoba

c.c. Kristy Forrestall, Brandon District Supervisor  
Cory Graham, Environmental Engineer (Permits & Licences)



# Attachment:      Engineering Design Plans

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# MUNICIPAL WASTE MANAGEMENT

## EXPANSION CELL DESIGN

ISSUED FOR CONSTRUCTION

### PLAN INDEX

#### GENERAL INFORMATION:

Plan 1 – Site Location Plan

#### CELL DESIGN:

Plan 2 – Waste Disposal Ground Existing Contour Plan

Plan 3 – Waste Disposal Ground Plan Layout

Plan 4 – Waste Disposal Ground Expansion Cell Elevation and Drainage Plan

Plan 5 – Road and Ramp Details

Plan 6 – Ramp Detail

Plan 7 – Dike, Liner and Leachate Pipe Details



Plan 8 – Page Wire Fence Detail Plan

Plan 9 – Silt Fence Detail Plan



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216 – 740 Rosser Avenue  
Brandon, Manitoba  
R7A 0K9  
(204) 727-8898

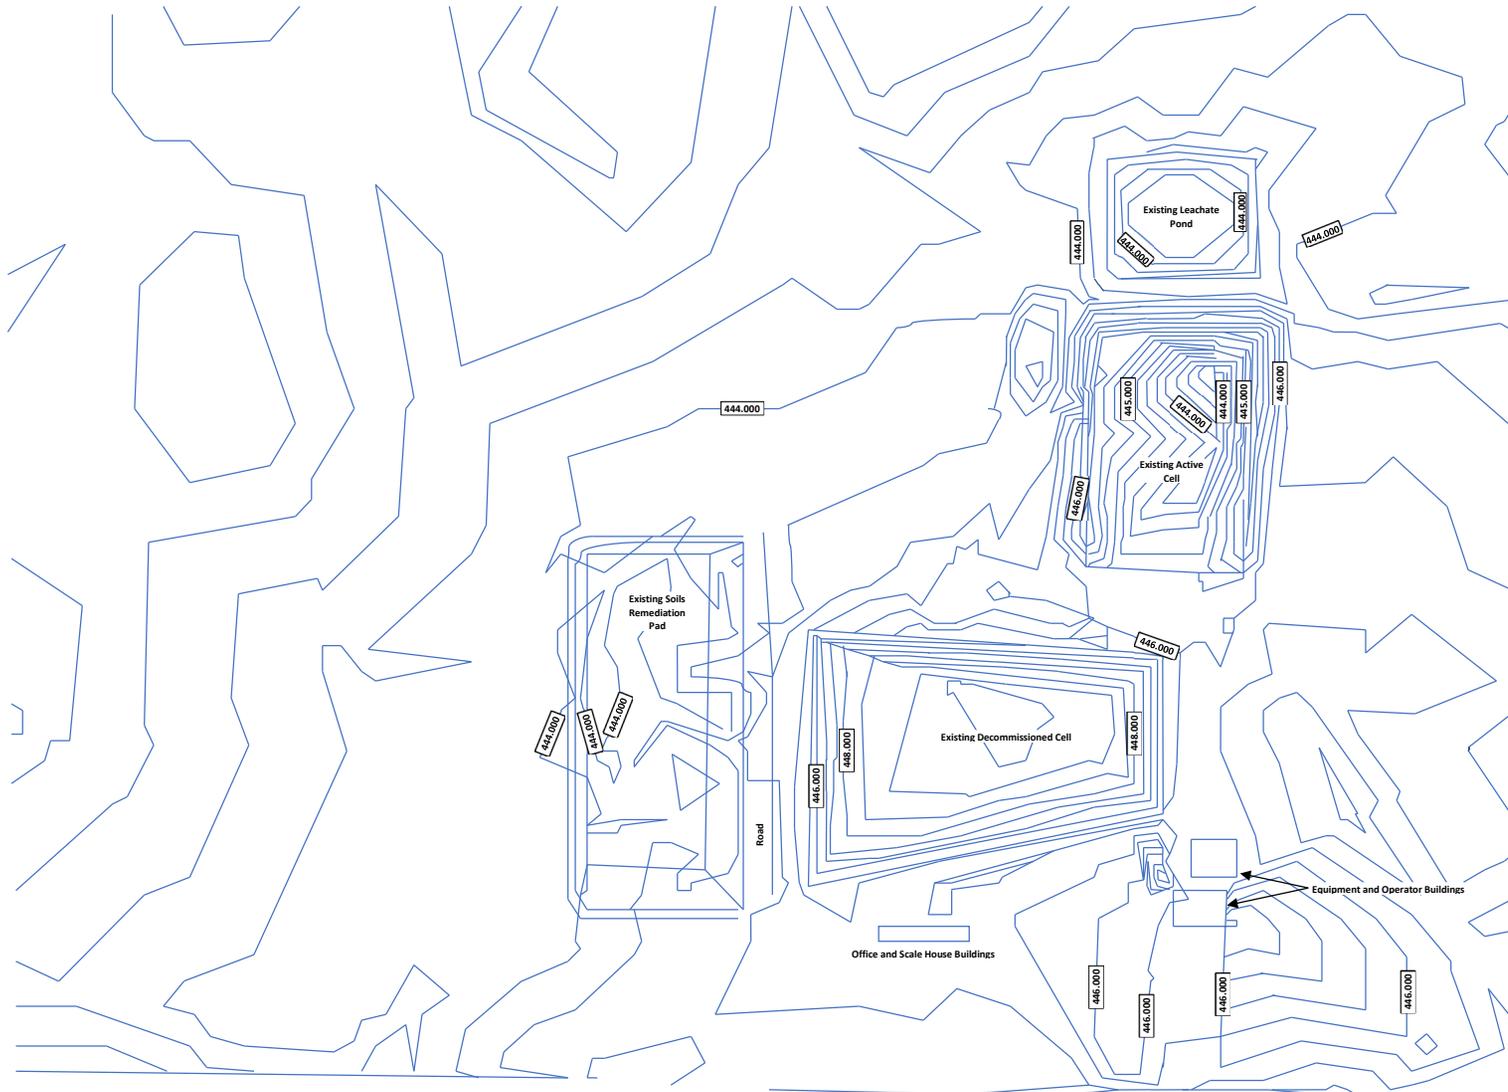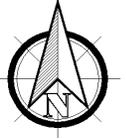

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LOCATIONS OF UNDERGROUND STRUCTURES/UTILITIES AS SHOWN ARE BASED ON AVAILABLE INFORMATION BUT NO GUARANTEE IS GIVEN OR IMPLIED THAT ALL EXISTING UNDERGROUND STRUCTURES/UTILITIES ARE SHOWN OR THAT THE GIVEN LOCATIONS ARE EXACT. CONFIRMATION OF EXISTENCE AND EXACT LOCATION OF ALL UNDERGROUND STRUCTURES/UTILITIES MUST BE OBTAINED FROM THE APPROPRIATE AUTHORITY/OWNER, BY THE CONTRACTOR, BEFORE PROCEEDING WITH CONSTRUCTION.

Title:

Waste Disposal Ground Existing Contour Plan

Project:

Municipal Waste Management

Date:

June 15, 2020

Drawn By:

DD

Checked By:

CN

Project No.:

ECS - 2020 - 003

Scale:

NTS

Plan:

2



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Title:

Waste Disposal Ground Layout Plan

Project:

Municipal Waste Management

Date:

June 15, 2020

Drawn By:

DD

Checked By:

CN

Project No.:



ECS - 2020 - 003

Scale:

NTS

Plan:

3

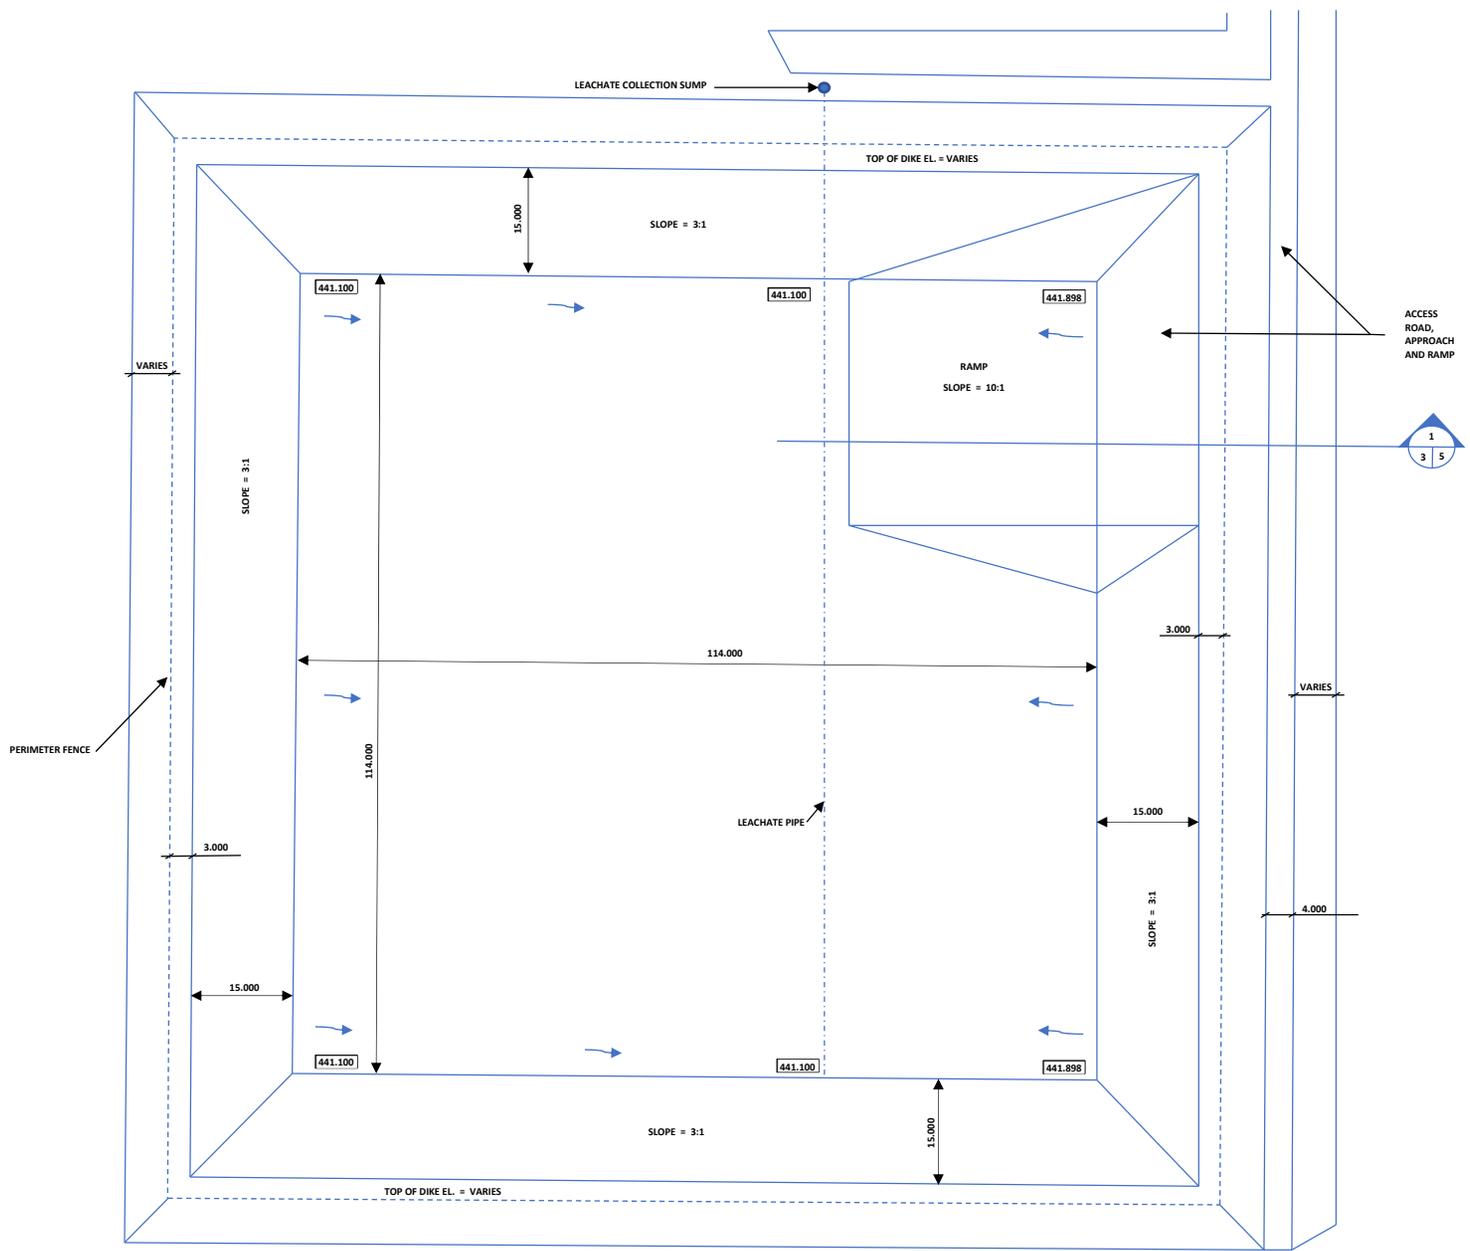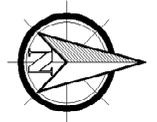

**LEGEND**

- Proposed Drainage
- Proposed Elevation 441.100



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Title: Waste Disposal Ground Expansion Cell Elevation & Drainage Plan

Project: Municipal Waste Management



Date: June 15, 2020

Drawn By: DD  
Checked By: CN

Project No.: ECS - 2020 - 003

Scale: 1:1000

Plan: 4

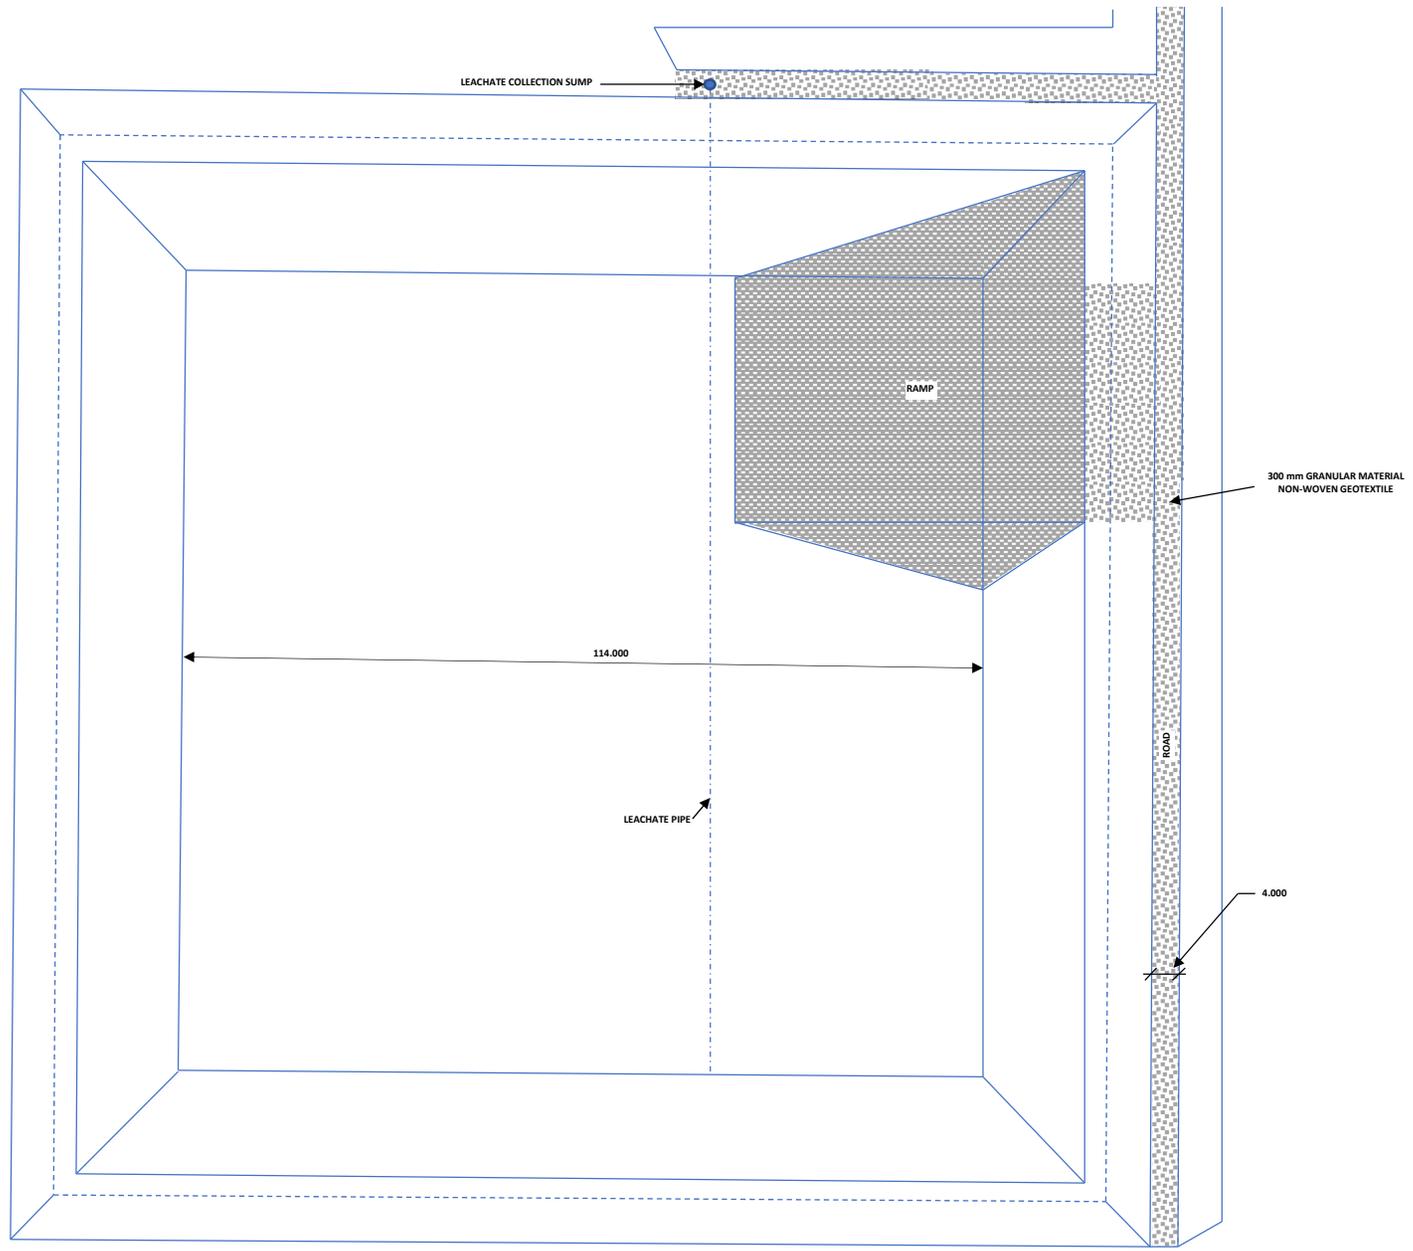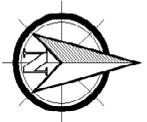

**LEGEND**

- Granular Material (as required)
- 300 mm Granular Material, over non-woven Geotextile



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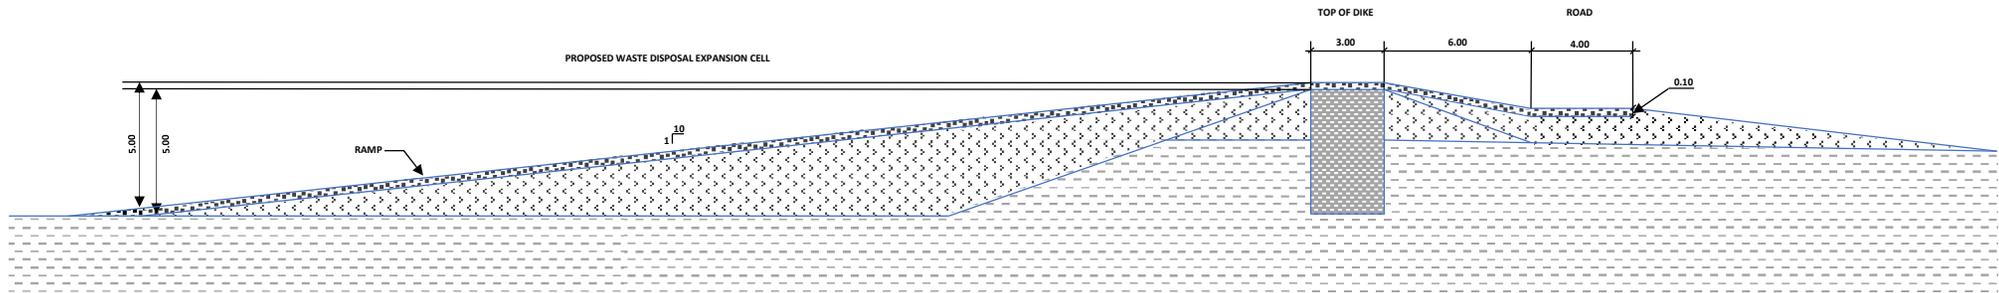
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Title:  
**Road and Ramp Details**

Project:  
**Municipal Waste Management**


Date: June 15, 2020	Drawn By: DD	Project No.: ECS - 2020 - 003	Scale: 1:1000	Plan: 5
	Checked By: CN			



1  
3 5  
RAMP TO WASTE DISPOSAL GROUND EXPANSION CELL  
SCALE = 1:300

LEGEND

-  Native Silty Clay
-  Excavated and Compacted Soil Material
-  Granular Material
-  Excavated and Compacted Silty Clay Type Soil

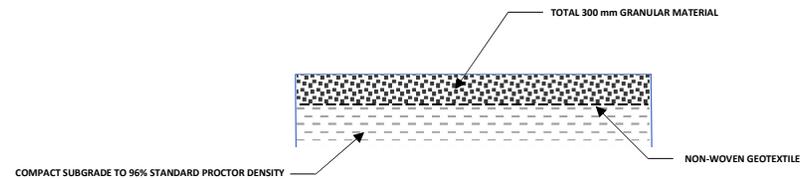

4  
7  
GRANULAR STRUCTURE FOR ROAD, APPROACH AND RAMP  
SCALE = NTS



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Title:

Ramp Detail

Project:

Municipal Waste Management

Date:

June 15, 2020

Drawn By:

DD

Checked By:

CN

Project No.:


ECS - 2020 - 003

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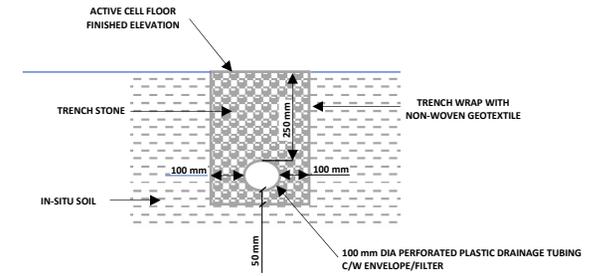
1:300

Plan:


6

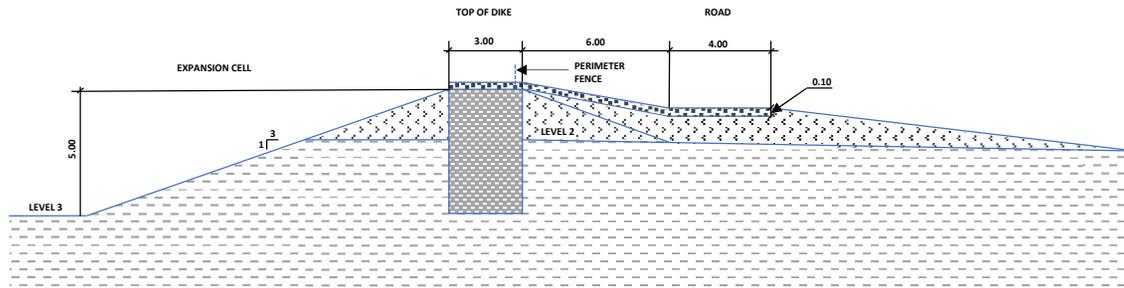

1  
4 EXPANSION CELL NORTH AND WEST PERIMETER DIKES  
SCALE = 1:300



4  
10 LEACHATE COLLECTION PIPING DETAIL  
SCALE = 1:25

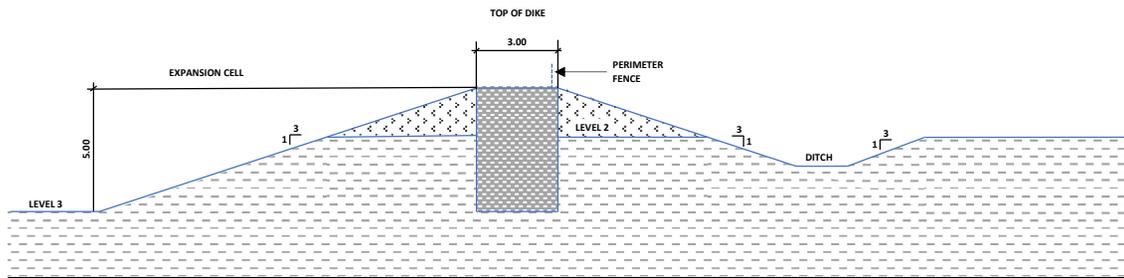

3  
4 EXPANSION CELL EAST AND SOUTH PERIMETER DIKE  
SCALE = 1:300

### LEGEND

-  Excavated and Compacted Silty Clay Type Soil
-  Excavated and Compacted Soil Material
-  IN-SITU
-  TRENCH STONE

- LEVEL 1 - PRE-CONSTRUCTION PRAIRIE ELEVATION
- LEVEL 2 - ELEVATION FOLLOWING STRIPPED ORGANICS/VEGETATION
- LEVEL 3 - FINISHED CELL BOTTOM ELEVATION
- LEVEL 2 AND 3 - TO BE COMPACTED WITH SHEEPSFOOT PACKER
- LEVEL 4 - BOTTOM OF NATIVE CLAY LINER

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Title:

Dike, Liner and Leachate Pipe Details

Project:

Municipal Waste Management

Date:

June 15, 2020

Drawn By:

DD

Checked By:

CN

Project No.:

ECS - 2020 - 003

Scale:

Various




Plan:

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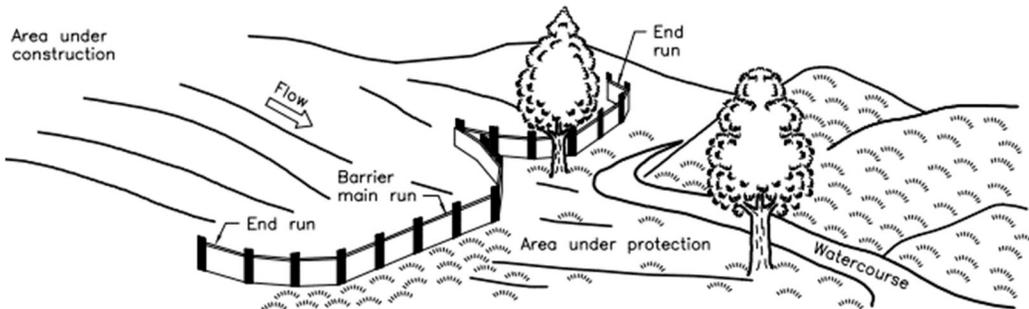
## PAGE WIRE FENCE DETAIL

### Notes:


1. 100 mm top diameter treated wood posts or commercial steel posts.
2. 150 mm corner and brace posts top diameter.
3. 100 mm diameter brace rial, notched and spiked into 2.
4. 4 mm (No. 9) brace wire, twist at two locations to tighten.
5. Start fencing at corners
6. Page wire fencing (see manufacturers specifications) use 1500 mm high.
7. Optional barbed wire top strand, at the discretion of MWM Environmental.
8. Corner - and end-post anchors, wired and spiked to post.

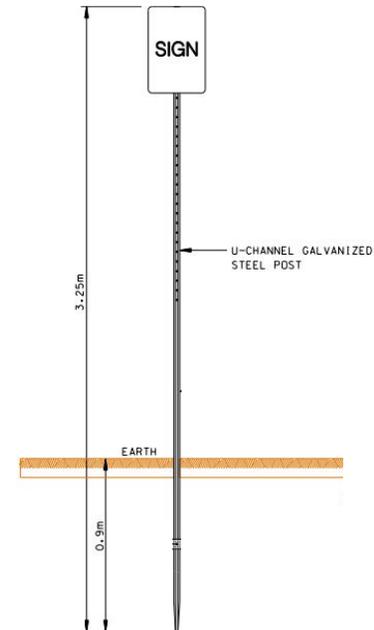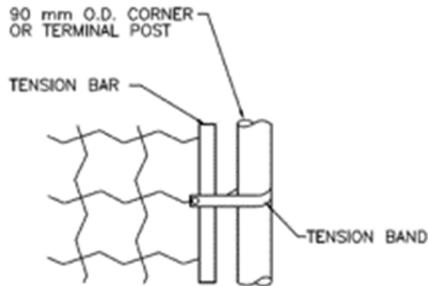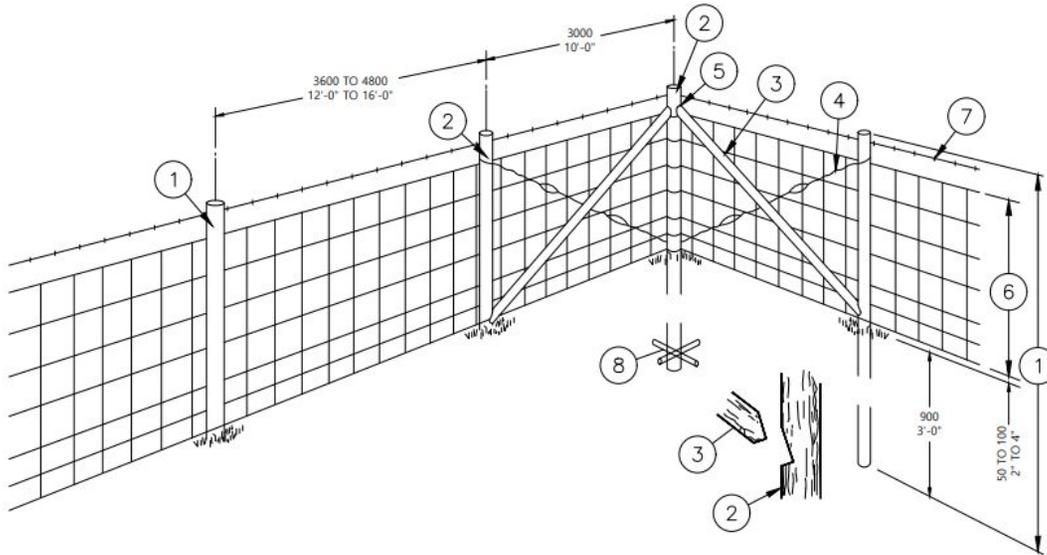



Note: All dimensions are in millimetres unless otherwise shown.



PERSPECTIVE VIEW

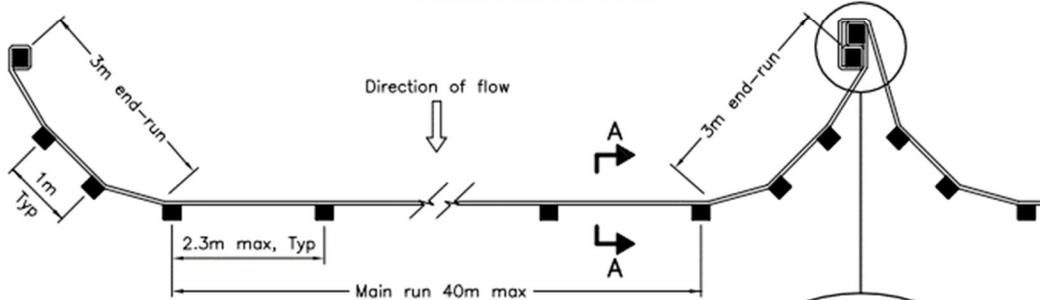

PLAN

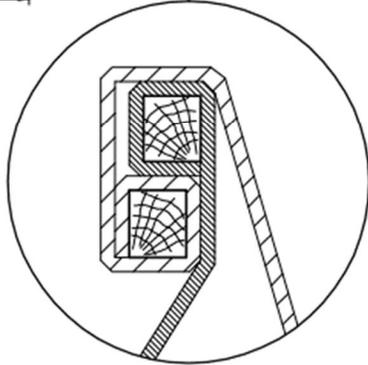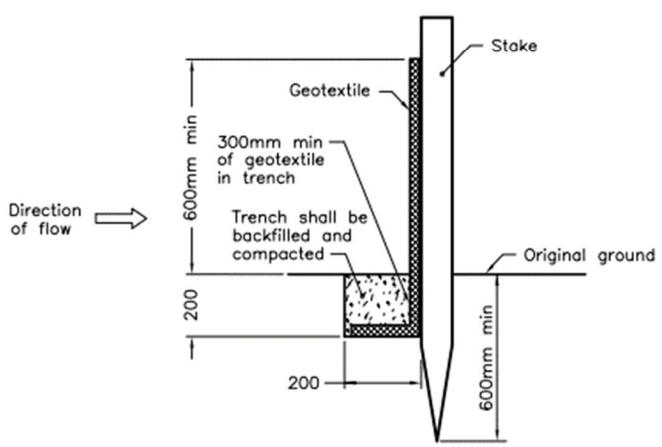

JOINT DETAIL

Note: All dimensions are in millimetres unless otherwise shown.

## SILT FENCE DETAIL

Notes:

1. The height of the silt fence shall not exceed 600 mm.
2. The filter fabric shall be purchased in a continuous roll cut to the length of the barrier to avoid the use of joints.
3. Posts shall be placed a maximum of 2.4 m apart at the barrier location and driven securely into the ground a minimum of 300 mm.
4. A trench shall be excavated approximately 100 mm wide and 100 mm deep along the line of posts and upslope from the barrier.
5. Standard strength filter fabric shall be stapled or wired to the fence, and 300 mm of the fabric shall be extended into the trench. The fabric shall not extend more than 600 mm above the original ground surface.
6. The trench shall be backfilled and the soil compacted over the filter fabric.
7. Silt fencing to be polypropylene synthetic fibre with ultraviolet stabilizers AMOCO 1196 or approved equivalent.
8. Wood posts to be 36 mm x 89 mm (2" x 4") pointed at one end and fabricated.
9. Install all supporting posts on the down slope side of the fencing.
10. Maintain silt fence throughout construction and until revegetation occurs.



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Title:

Silt Fence Detail Plan

Project:

Municipal Waste Management

Date:

June 15, 2020

Drawn By:

DD

Checked By:

CN

Project No.:

ECS - 2020 - 003

Scale:

NTS

Plan:

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